



PORT ALBERNI SECONDARY - CHANGE ROOM RENOVATION

4000 ROGER ST, PORT ALBERNI, BC

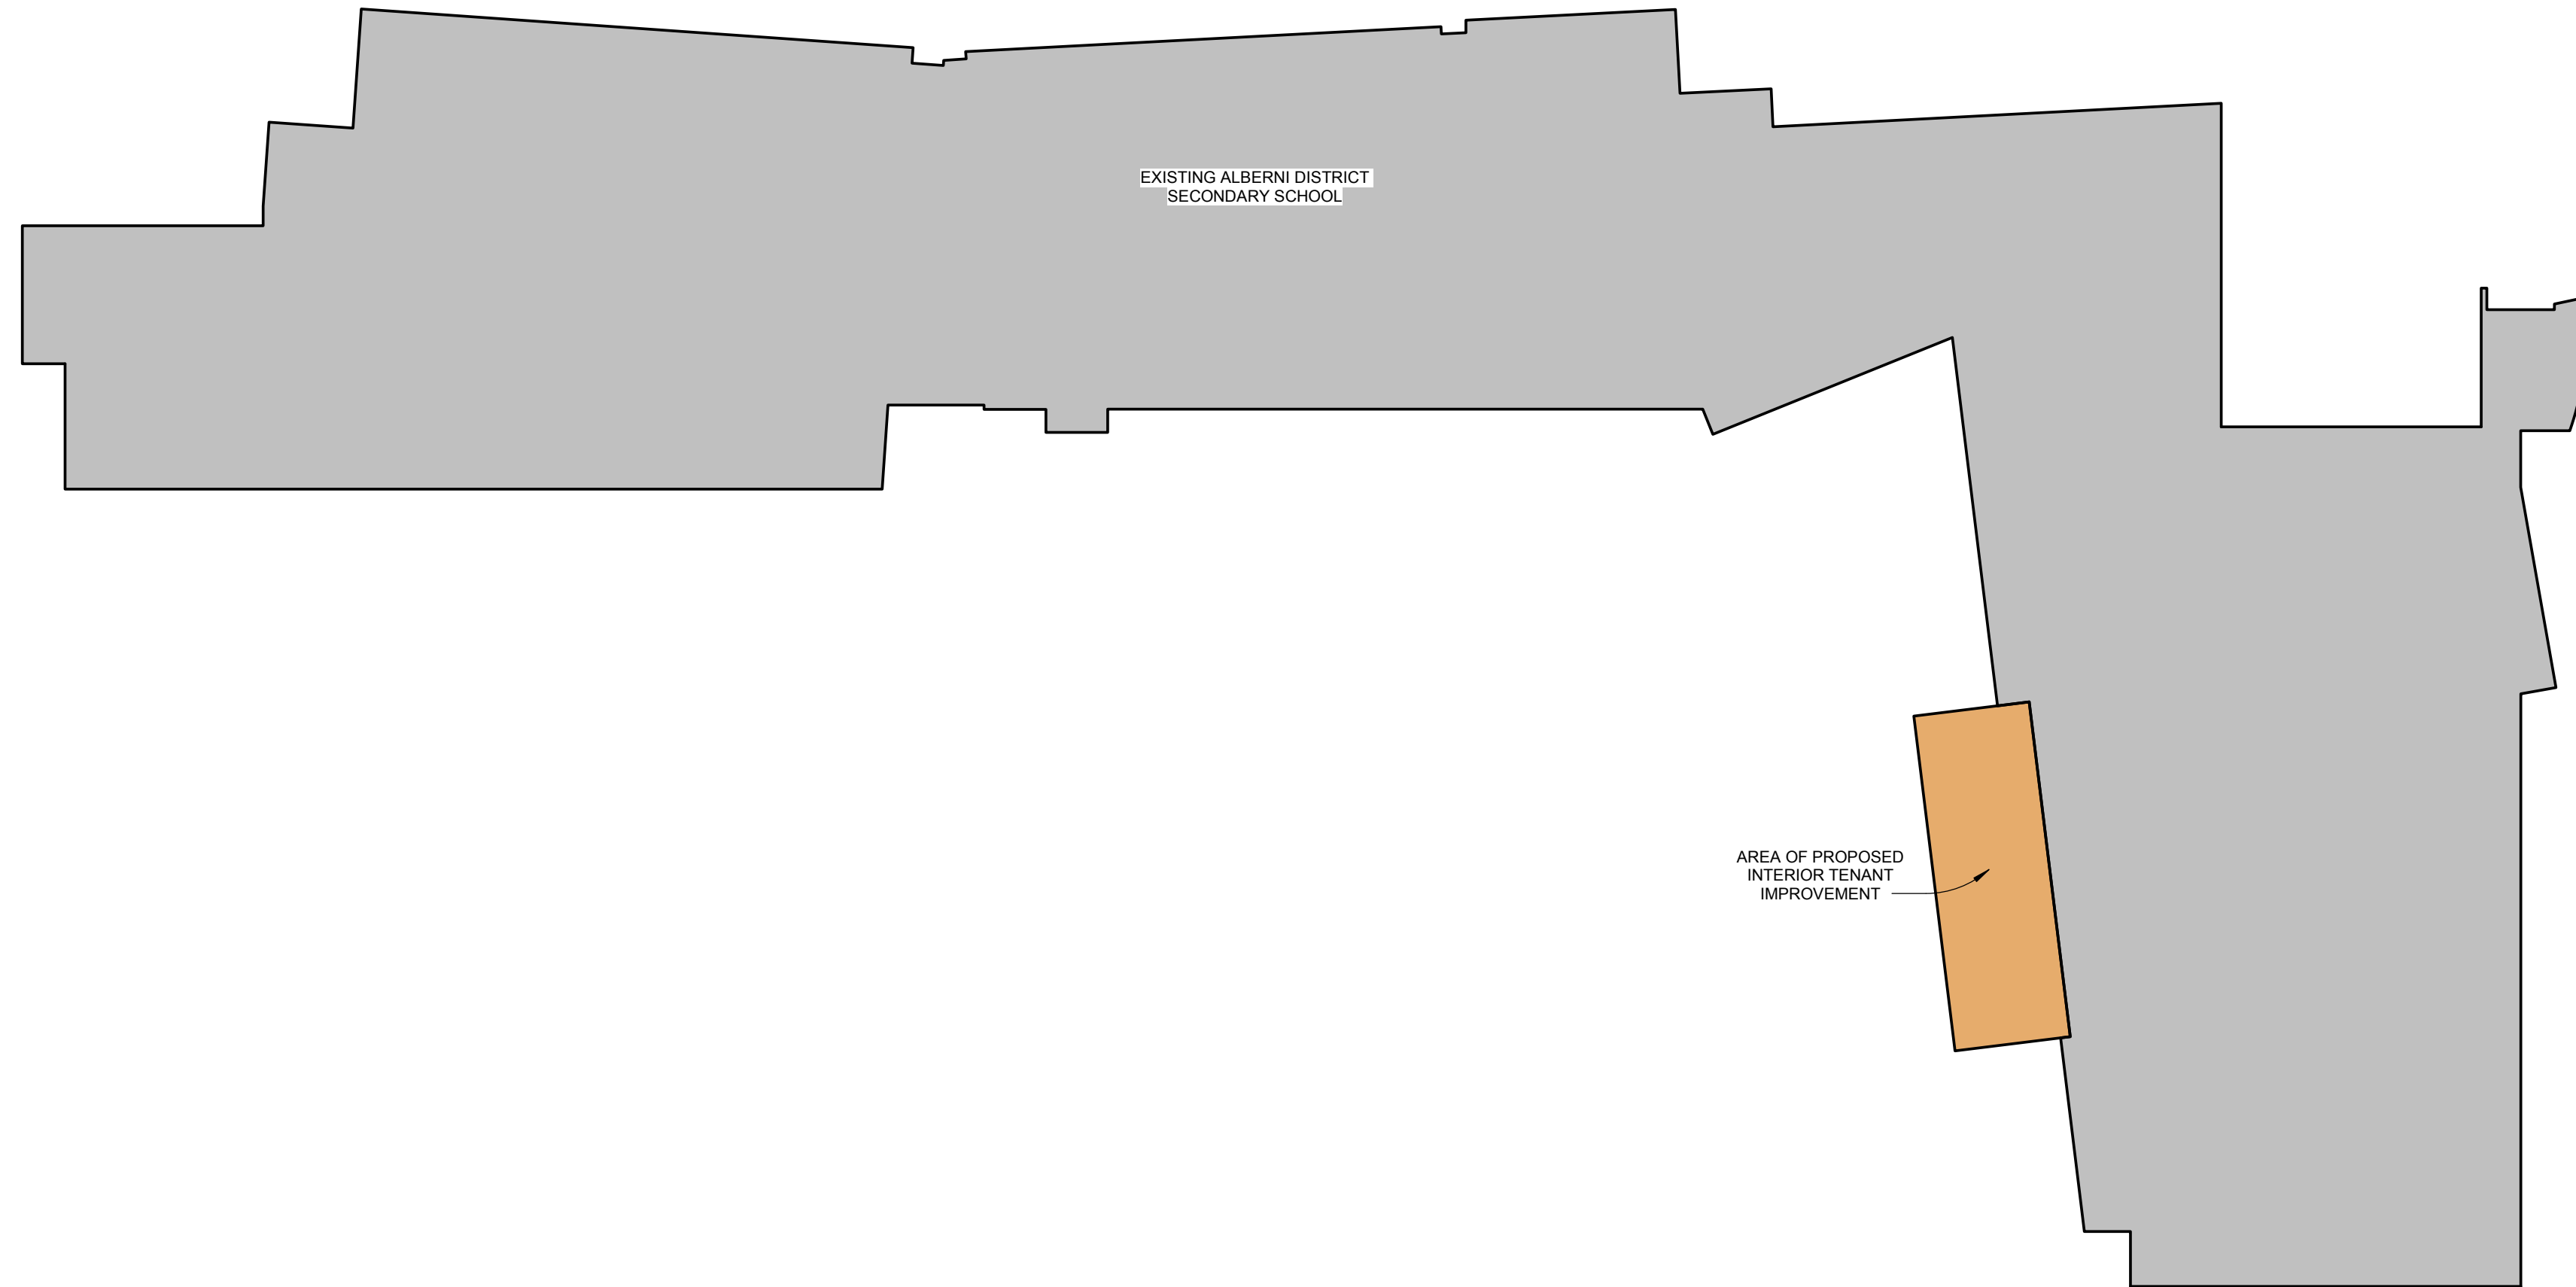

SITE LOCATION MAP (N.T.S.)

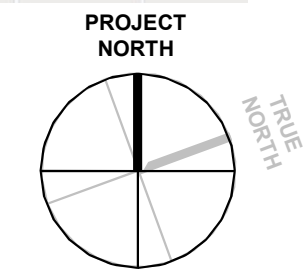

REVISION - RECORD		
No.	DATE	DESCRIPTION

DESIGN DEVELOPMENT

1 KEY PLAN

1 : 500

ABBREVIATION LEGEND

#	POUND OR NUMBER	HVAC	HEATING, VENTILATING, AND AIR CONDITIONING
&	AND	IRGWB	IMPACT RESISTANT GYPSUM WALL BOARD
@	AT	ILO	IN LIEU OF
ACT	ACOUSTIC CEILING TILE	INSUL	INSULATED OR INSULATION
AFF	ABOVE FINISHED FLOOR	INT	INTERIOR
ALUM	ALUMINUM	LO	LOW
ANOD	ANODIZED	MAX	MAXIMUM
BYND	BEYOND	MO	MASONRY OPENING
BOT	BOTTOM	MECH	MECHANICAL
CJ	CONTROL JOINT	MIN	MINIMUM
CLG	CEILING	MRGWB	MOISTURE-RESISTANT GYPSUM WALL BOARD
CLR	CLEAR	MTL	METAL
CMU	CONCRETE MASONRY UNIT	NIC	NOT IN CONTRACT
COL	COLUMN	NO	NUMBER
CONC	CONCRETE	NOM	NOMINAL
CONT	CONTINUOUS	OC	ON CENTER
CPT	CARPET	OSCI	OWNER SUPPLY, CONTRACTOR INSTALL
CSCI	CONTRACTOR SUPPLY, CONTRACTOR INSTALL	OSOI	OWNER SUPPLY, OWNER INSTALL
CT	CERAMIC TILE	PLUMB	PLUMBING
C/W	COMPLETE WITH	PLYD	PLYWOOD
DBL	DOUBLE	PNT/PTD	PAINT OR PAINTED
DEMO	DEMOLISH OR DEMOLITION	PSF	PRESSED STEEL FRAME
DIA	DIAMETER	RBR	RUBBER
DIM/DIMS	DIMENSION/DIMENSIONS	RCP	REFLECTED CEILING PLAN
DN	DOWN	REQD	REQUIRED
DR	DOOR	RM	ROOM
DWG	DRAWING	SIM	SIMILAR
EA	EACH	SPEC	SPECIFIED OR SPECIFICATION
EL	ELEVATION	SPK	SPRINKLER OR SPEAKER
ELEC	ELECTRICAL	SSTL	STAINLESS STEEL
ELEV	ELEVATOR OR ELEVATION	STC	SOUND TRANSMISSION COEFFICIENT
EQ	EQUAL	STL	STEEL
EXIST	EXISTING	STRUCT	STRUCTURE OR STRUCTURAL
EXT	EXTERIOR	TELE	TELEPHONE
FD	FLOOR DRAIN OR FIRE DEPARTMENT	TLT	TOILET
FEC	FIRE EXTINGUISHER CABINET	TME	TO MATCH EXISTING
FIXT	FIXTURE	TO	TOP OF
FLR	FLOOR	TCC	TOP OF CONCRETE
FO	FACE OF	TOS	TOP OF STEEL
FND	FOUNDATION	TPD	TOILET PAPER DISPENSER
GA	GAUGE	TYP	TYPICAL
GALV	GALVANIZED	UNO	UNLESS NOTED OTHERWISE
GWB	GYPSUM WALL BOARD	UIS	UNDERSIDE
HG	HOLLOW CORE	VIF	VERIFY IN FIELD
HI	HIGH	VP	VISION PANEL
HM	HOLLOW METAL	W/	WITH
HR	HOUR	WD	WOOD

GENERAL NOTES

- ALL WORK SHALL CONFORM TO THE REQUIREMENTS OF BRITISH COLUMBIA BUILDING CODE 2018, ALL APPLICABLE CSA STANDARDS AND ALL LOCAL AND MUNICIPAL BY-LAWS AND CODES.
- ALL WORK SHALL BE EXECUTED ACCORDING TO THE BEST TRADE PRACTICES, BEING SQUARE, PLUMB AND TRUE TO LINE.
- READ, CHECK AND COMPARE ALL DRAWINGS. NOTIFY THE ARCHITECT OF ANY/ALL DISCREPANCIES.
- CHECK AND VERIFY EXISTING CONDITIONS AS SHOWN. NOTIFY THE ARCHITECT OF ANY/ALL DISCREPANCIES.
- VERIFY ALL DIMENSIONS BEFORE CONSTRUCTION/ FABRICATION OF ALL COMPONENTS. DIMENSIONS ARE TO FACE OF STUD OR TO FACE OF SHEATHING, GRID LINES, FACE OF CONCRETE AND FACE OF MASONRY WALLS EXCEPT AS NOTED.
- GLAZING DIMENSIONS ARE FRAME DIMENSIONS U.N.O.
- REFER TO WALL SCHEDULES FOR WALL TYPES (TO BE READ IN CONJUNCTION WITH ALL DRAWINGS INCLUDING PLANS, WALL SECTIONS AND DETAILS, ETC.)
- SOUND INSULATED WALLS (ACOUSTIC PARTITIONS): GYPSUM WALLBOARD TO BOTH SIDES OF WALL SHALL CONTINUE TO UNDERSIDE OF DECK, FLOOR OR ROOF STRUCTURE, AND TO BE COMPLETE WITH SOUND SEALS AT DECK FLUTES AT TOP OF WALL AND ACOUSTIC SEALANT AT TOP AND BOTTOM OF WALLS ON BOTH SIDES. SOUND INSULATE AROUND ALL OFFICES, WASHROOMS, CHANGE ROOMS AND WHERE INDICATED ON PLANS.
- FOR FIRE SEPARATIONS AND ASSEMBLY RATINGS, REFER TO CODE ANALYSIS/ COMPLIANCE DRAWINGS, FLOOR PLANS AND WALL SCHEDULES.
- CONTINUITY OF FIRE SEPARATION I.E. CONTINUITY OF GWB TO BE MAINTAINED AT INTERVENING NON RATED PARTITIONS, BEHIND MILLWORK, SHOWERS, RECESSED ELECTRICAL PANELS & FIRE EXTINGUISHERS, ETC.
- PROVIDE SOLID BLOCKING IN WALLS & FLOORS FOR ALL WALL MOUNTED FIXTURES, ACCESSORIES, EQUIPMENT, MILLWORK, ETC WHERE AND AS REQUIRED.
- FOR LOCATION OF WASHROOM ACCESSORIES, REFER TO CORRESPONDING WASHROOMS PLANS AND DETAILS.
- FOR INTERIOR FINISHES REFER TO INTERIOR ELEVATIONS AND ROOM AND FINISH SCHEDULES.
- ITEMS CROSS-HATCHED OR MARKED "N.I.C." ARE "NOT IN CONTRACT".
- PROVIDE BLOCKING IN WALLS & FLOORS AS REQUIRED.
- FOR CONCRETE HOUSEKEEPING PADS SEE STRUCTURAL, MECHANICAL AND ELECTRICAL DRAWINGS.
- FOR FLOOR DRAINS ALSO SEE MECHANICAL.
- WHERE COMPARTMENTALIZATION OF CONCEALED SPACES IS REQUIRED BY CODE, PROVIDE MIN. 0.38mm THICK METAL SHEET CLOSURES TO SUIT AT MAX. 20 m HORIZONTALLY AND AT 3 m VERTICALLY AT EACH FLOOR LEVEL. THIS INCLUDES ALL RAINSCREEN CAVITIES GREATER THAN 25mm THAT CONTAIN COMBUSTIBLE INSULATION AND OTHER ELEMENTS. CLOSURES MUST BE SUFFICIENT TO STOP THE SPREAD OF FLAME AS PER BCBC AND ACCEPTABLE TO THE AUTHORITY HAVING JURISDICTION.
- PROVIDE FIRE PROTECTION TO STRUCTURE AS REQUIRED PER CODE COMPLIANCE TABLE.
- PROVIDE SHOP DRAWINGS SUBMITTALS FOR ALL SECONDARY COMPONENTS & THEIR ATTACHMENTS. THE COMPONENTS SHALL BE DESIGNED, DRAWINGS SIGNED & SEALED BY THE SPECIALTY P.ENG. C/W LETTERS OF ASSURANCE.

ARCHITECTURAL DRAWING LIST

A0.0.0	COVER SHEET
A0.0.1	SURVEY
A2.0.1	DEMO FLOOR PLANS
A2.1.1	MAIN FLOOR PLAN
A2.2.1	FLOOR FINISH & INTERIOR PLAN
A3.1.1	REFLECTED CEILING PLANS
A7.1.1	INTERIOR ELEVATIONS
A9.1.1	TYPICAL INTERIOR DOOR & SCREEN FRAME DETAILS
A9.2.1	DOOR SCHEDULE C/W TYP DOOR ELEVATIONS
A9.3.1	INTERIOR GLAZED SCREEN SCHEDULE

ELECTRICAL DRAWING LIST

E000	COVER SHEET
------	-------------

MECHANICAL DRAWING LIST

M000	COVER SHEET
------	-------------

STRUCTURAL DRAWING LIST

S000	COVER SHEET
------	-------------

CONTACT LIST

OWNER	GREG ROE SCHOOL DISTRICT NO. 70 4680 ROGER STREET PORT ALBERNI, BC (P) 250-723-8821 (E) GROE@SD70.BC.CA
ARCHITECTURAL	VALERIE O'LEARY KMBA ARCHITECTS & PLANNERS INC. 300-152 W. HASTINGS ST., VANCOUVER, B.C. V6B 1G8 (P) 604-732-3361, (E) VOLEARY@KMBA.COM
STRUCTURAL	LEE ROWLEY HEROLD ENGINEERING LTD. 3701 SHENTON ROAD NANAIMO, BC V9T 2H1 (P) 250-751-8558,(E)...
MECHANICAL	STEPHEN MCNICHOLLS SMCN CONSULTING INC. NANAIMO, BC (P) 250-616-3232, (E) STEPHEN@SMCN.CA
ELECTRICAL	LES BROWN R8 ENGINEERING LTD. 1855 NORTHFIELD ROAD NANAIMO, BC V9S 3B3 (P) 250-756-4444, (E) LES@RBENGINEERING.COM

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PROJECT TITLE:
**PORT ALBERNI
 SECONDARY -
 CHANGE ROOM
 RENOVATION**

4000 Roger St, Port Alberni, BC V9Y 0B1
 CLIENT:

**SCHOOL DISTRICT
 NO. 70 (ALBERNI)**

DRAWING TITLE:
COVER SHEET


PROJECT NUMBER:
20354

DRAWN: VOL SCALE: As indicated

DATE: 04-22-20

DRAWING NUMBER:

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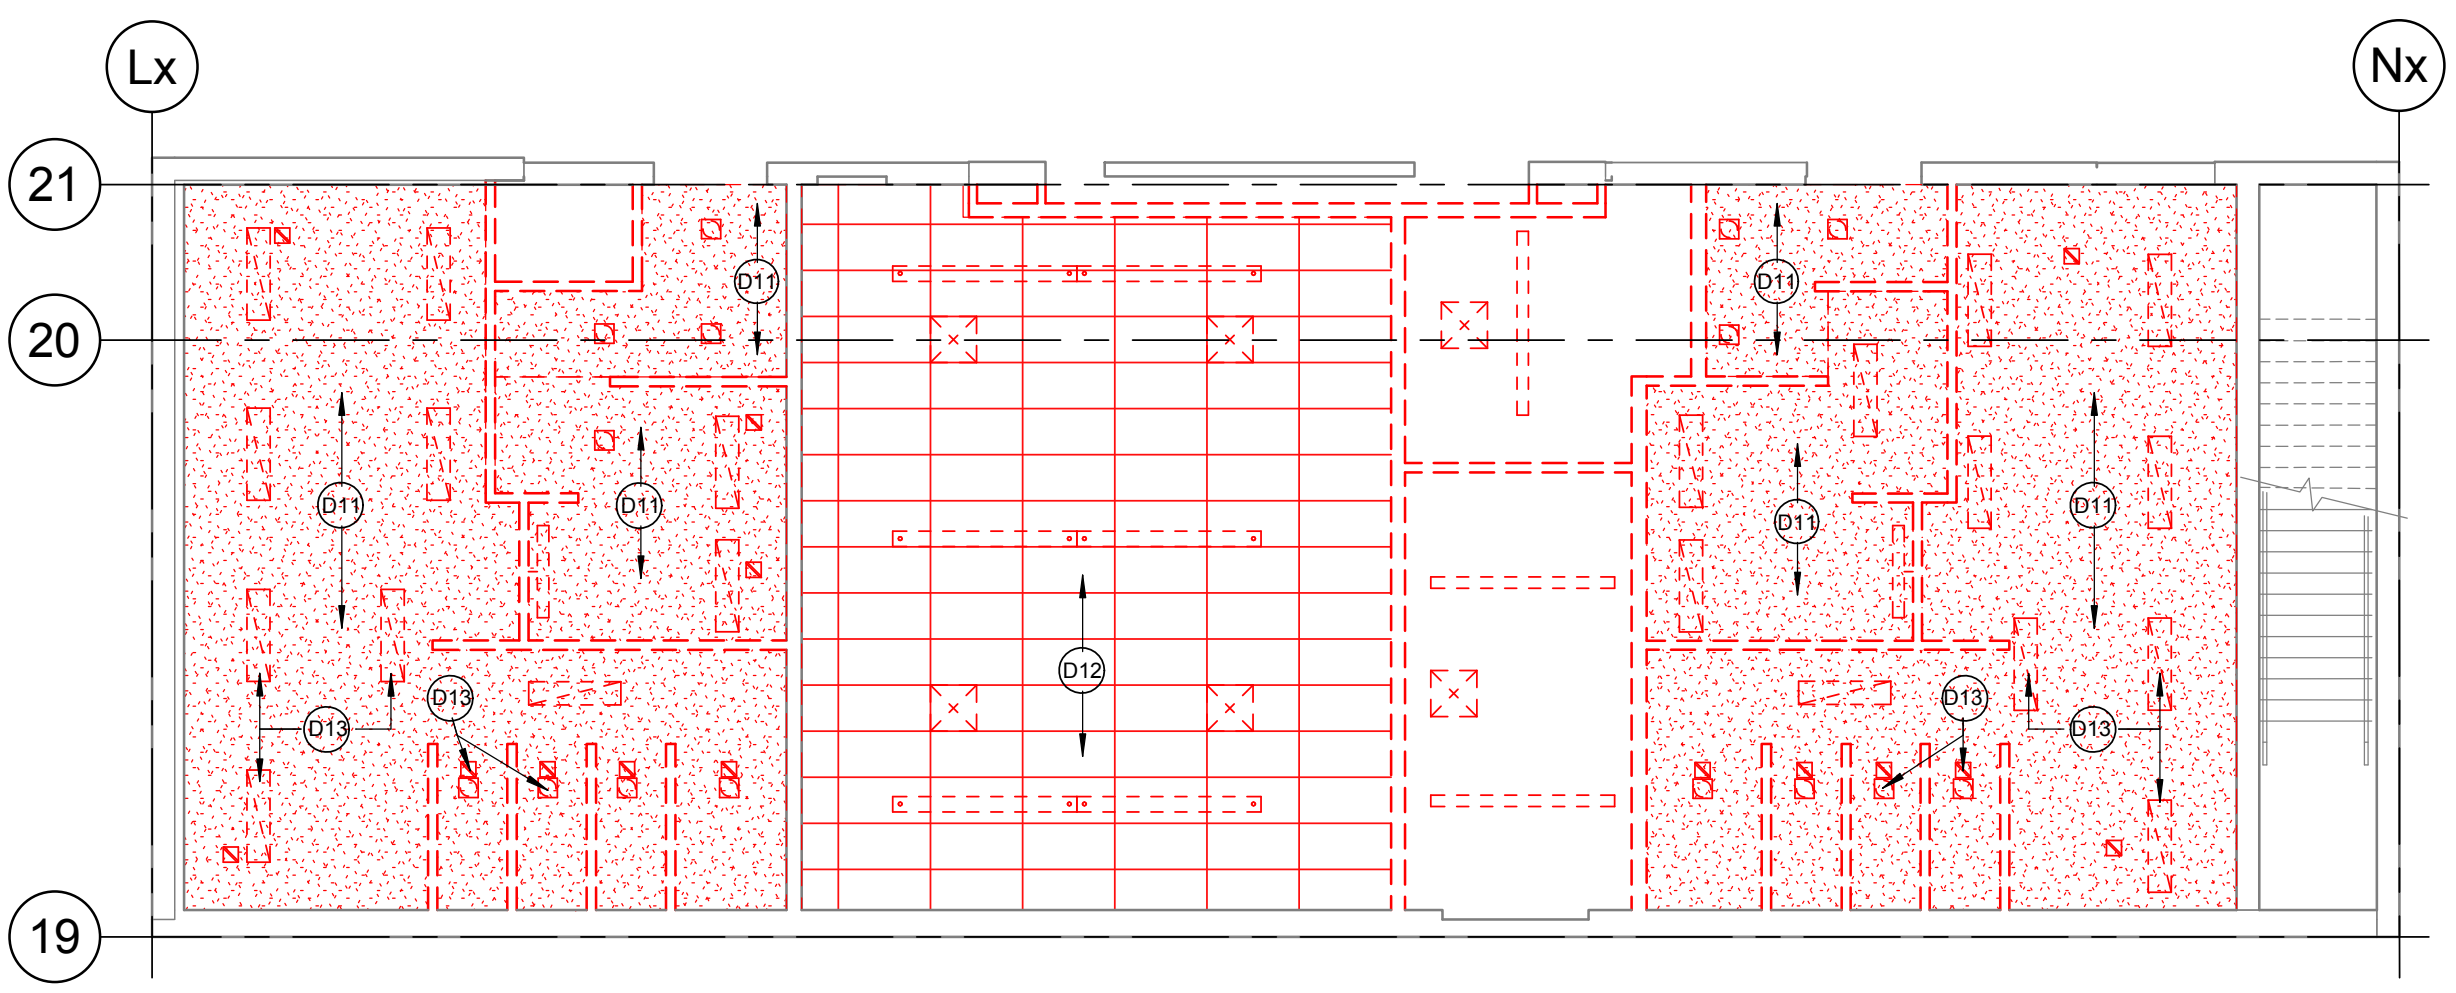


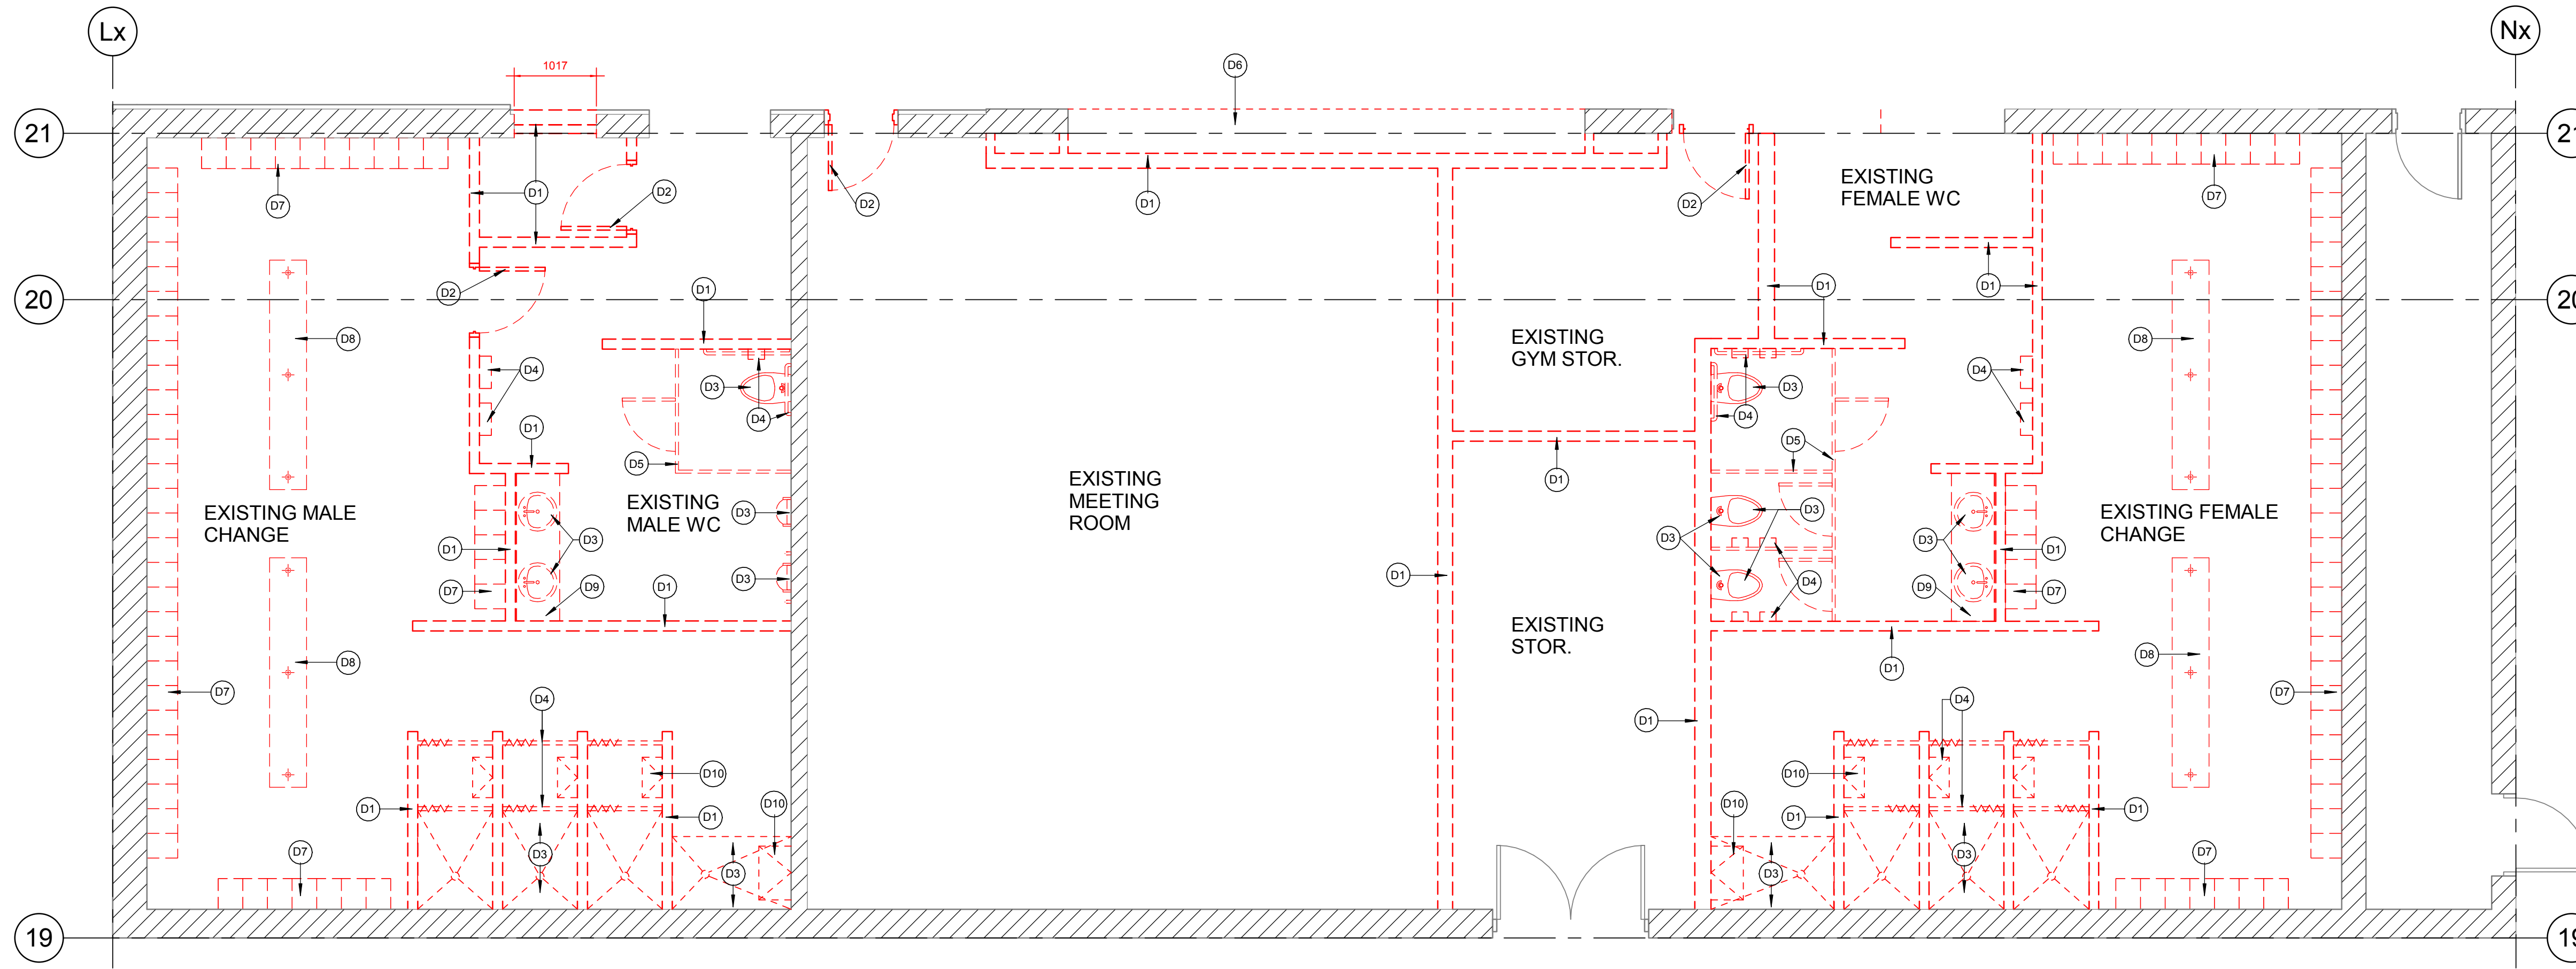1 A200 - MAIN FLOOR - DEMO
 1:50

DEMO FLOOR PLAN KEY NOTES

- D1 - REMOVE EXISTING STUD WALLS.
- D2 - REMOVE EXISTING DOOR AND FRAME FROM STUD WALL. - TO BE REUSED IN NEW SPACE - REFER TO DOOR SCHEDULE ON A9.1.1
- D3 - REMOVE EXISTING PLUMBING FIXTURES - TO BE REUSED IN NEW SPACE.
- D4 - REMOVE EXISTING WASHROOM ACCESSORIES - TO BE REUSED IN NEW SPACE
- D5 - REMOVE EXISTING WASHROOM PARTITIONS AND DOORS.
- D6 - REMOVE EXISTING MILLWORK DISPLAY CABINET.
- D7 - REMOVE EXISTING LOCKERS AND TURN OVER TO OWNER.
- D8 - REMOVE EXISTING BENCH AND TURN OVER TO OWNER
- D9 - REMOVE EXISTING MILLWORK VANITY.
- D10 - REMOVE EXISTING WALL MOUNTED BENCH. RE-USE IN PROPOSED SH 111 & SH 118
- D11 - REMOVE EXISTING GWB, CEILING
- D12 - REMOVE EXISTING T-BAR AND ACOUSTIC CEILING TILE.
- D13 - REMOVE EXISTING LIGHT FIXTURE - RETAIN FOR USE IN NEW SPACE
- D14 - REMOVE EXISTING MECHANICAL EQUIPMENT.

REVISION - RECORD		
No.	DATE	DESCRIPTION



2 MAIN FLOOR REFLECTED CEILING PLAN - DEMO
 1:100

DEMO FLOOR PLAN NOTES

1. CONTRACTOR TO NOTIFY DESIGN CONSULTANT & OWNER OF ANY MODIFICATIONS REQUIRED TO THE BASE BUILDING DEMOLITION PRIOR TO COMMENCEMENT OF WORK. ALL DRAWINGS ARE TO BE VERIFIED BY THE CONTRACTOR WITH REFERENCE TO EXISTING CONDITIONS. VERIFY ALL DIMENSION BEFORE DEMOLITION.
2. KEYNOTES ARE TO HIGHLIGHT GENERAL DEMOLITION REQUIREMENTS ONLY. READ IN CONJUNCTION WITH ALL ARCHITECTURAL ALL CONSULTANT DRAWINGS.
3. DEMOLITION OF ANY EXISTING STRUCTURAL SLAB, WALLS, FOUNDATIONS AND OPEN WEB JOISTS ARE TO BE APPROVED BY STRUCTURAL ENGINEER PRIOR TO COMMENCEMENT OF WORK.
4. MATCH, PATCH AND REPAIR FINISHES AS NECESSARY TO MATCH ADJACENT EXISTING FINISHES (SEE ALSO ROOM FINISH SCHEDULE).
5. SEE ALSO REFLECTED CEILING PLANS FOR DEMOLITION WORK.
6. WALLS, DOORS, ROOFS, FLOORS, STAIRS, WINDOWS AND MILLWORK TO BE REMOVED ARE SHOWN WITH A DASHED LINE. REMOVE ALL ATTACHMENTS (E.G. SPEAKERS, CLOCKS, SHELVING UNITS, TACKBOARD ETC.) AND TURN OVER TO OWNER.
7. EXISTING STRUCTURE TO REMAIN UNLESS NOTED OTHERWISE.
8. REMOVE ALL FLOOR FINISHES WHERE NOTED IN RENOVATED AREAS AND SCRAPE OFF WALL GLUE OR RESIDUE SO THAT SUB-FLOOR IS CLEAN AND SMOOTH BEFORE RECEIVING NEW UNDERLAYMENT AND FINISHES SPECIFIED.
9. SEE EXTERIOR ELEVATIONS FOR ADDITIONAL DEMOLITION WORK. (E.G. YARD LIGHTS, MECHANICAL GRILLES AND HOODS, OUT-BUILDINGS ETC.) REFER ALSO TO DETAILS AND RENOVATION PLANS FOR LOCATIONS WHERE DEMOLITION IS REQUIRED BY NEW CONSTRUCTION.
10. CONFIRM WITH STRUCTURAL ENGINEER BEFORE COMMENCING ANY DEMOLITION OF LOAD-BEARING STRUCTURE (E.G. WALLS, COLUMNS, BEAMS ETC.)
11. WHERE NOTED, ALL EXISTING EXTERIOR WINDOWS, TRIMS AND SILLS ARE TO BE REMOVED AND REPLACED WITH NEW WINDOWS AS SHOWN ON EXTERIOR ELEVATIONS.
12. WHERE NOTED, ALL EXISTING EXTERIOR WALL AND ROOF FINISHES ARE TO BE STRIPPED DOWN TO EXISTING SHIPLAP AND ALL INTERIOR FINISHES ARE TO BE STRIPPED DOWN TO EXISTING WOOD STUDS.
13. REMOVE ALL EXISTING INSULATION IN WALLS, CEILING AND ROOF SPACES.
14. REVIEW ASBESTOS REPORT FOR LOCATION, HANDLING AND DISPOSAL OF HAZARDOUS MATERIALS.
15. SEE CIVIL AND LANDSCAPE DRAWINGS FOR EXISTING SITE ELEMENTS TO BE REMOVED INCLUDING UNDERGROUND UTILITIES, STAIRS & LANDINGS, RAMPS, HARD SURFACES AND VEGETATION.
16. WHERE EXISTING MILLWORK IS REMOVED, ENSURE SERVICES ARE CAPPED OFF SAFELY PRIOR TO DEMOLITION (CO-ORDINATE WITH MECHANICAL & ELECTRICAL) TURN OVER TO OWNER SINKS, ACCESSORIES AND APPLIANCES WHERE SHOWN ON DRAWINGS.

DEMO FLOOR PLAN LEGEND

	EXISTING WALL TO REMAIN
	EXISTING WALL TO BE DEMOLISHED
	EXISTING DOOR IN EXISTING FRAME TO REMAIN
	EXISTING DOOR AND FRAME TO BE REMOVED
	EXISTING WINDOWS AND ASSOCIATED COMPONENTS TO BE DEMOLISHED
	EXISTING MILLWORK, FIXTURES, STAIRS AND GUARDRAILS TO BE REMOVED
	CUT AND PATCH EXISTING FLOOR
	EXTENT OF DEMOLITION AND/OR NOTE
	EXISTING LIGHT FIXTURES TO BE REMOVED
	EXISTING MECHANICAL EQUIPMENT TO BE REMOVED
	DEMOLITION KEYNOTES INDICATOR
	EXISTING GWB, CEILING TO BE REMOVED

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PROJECT TITLE:
**PORT ALBERNI
 SECONDARY -
 CHANGE ROOM
 RENOVATION**

4000 Roger St, Port Alberni, BC V9Y 0B1
 CLIENT:

**SCHOOL DISTRICT
 NO. 70 (ALBERNI)**

DRAWING TITLE:
DEMO FLOOR PLANS

PROJECT NUMBER:
20354

DRAWN: VOL SCALE: As indicated

DATE: 04/23/20


DRAWING NUMBER:

A2.0.1

DESIGN DEVELOPMENT

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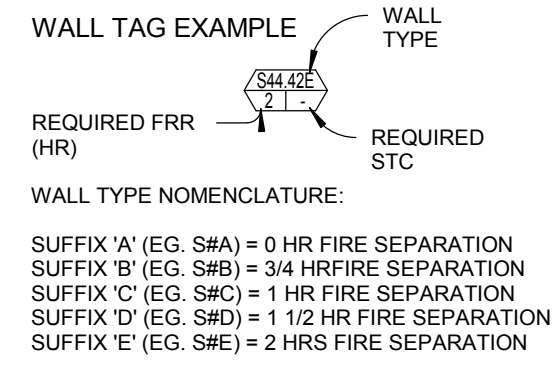


REVISION - RECORD		
No.	DATE	DESCRIPTION

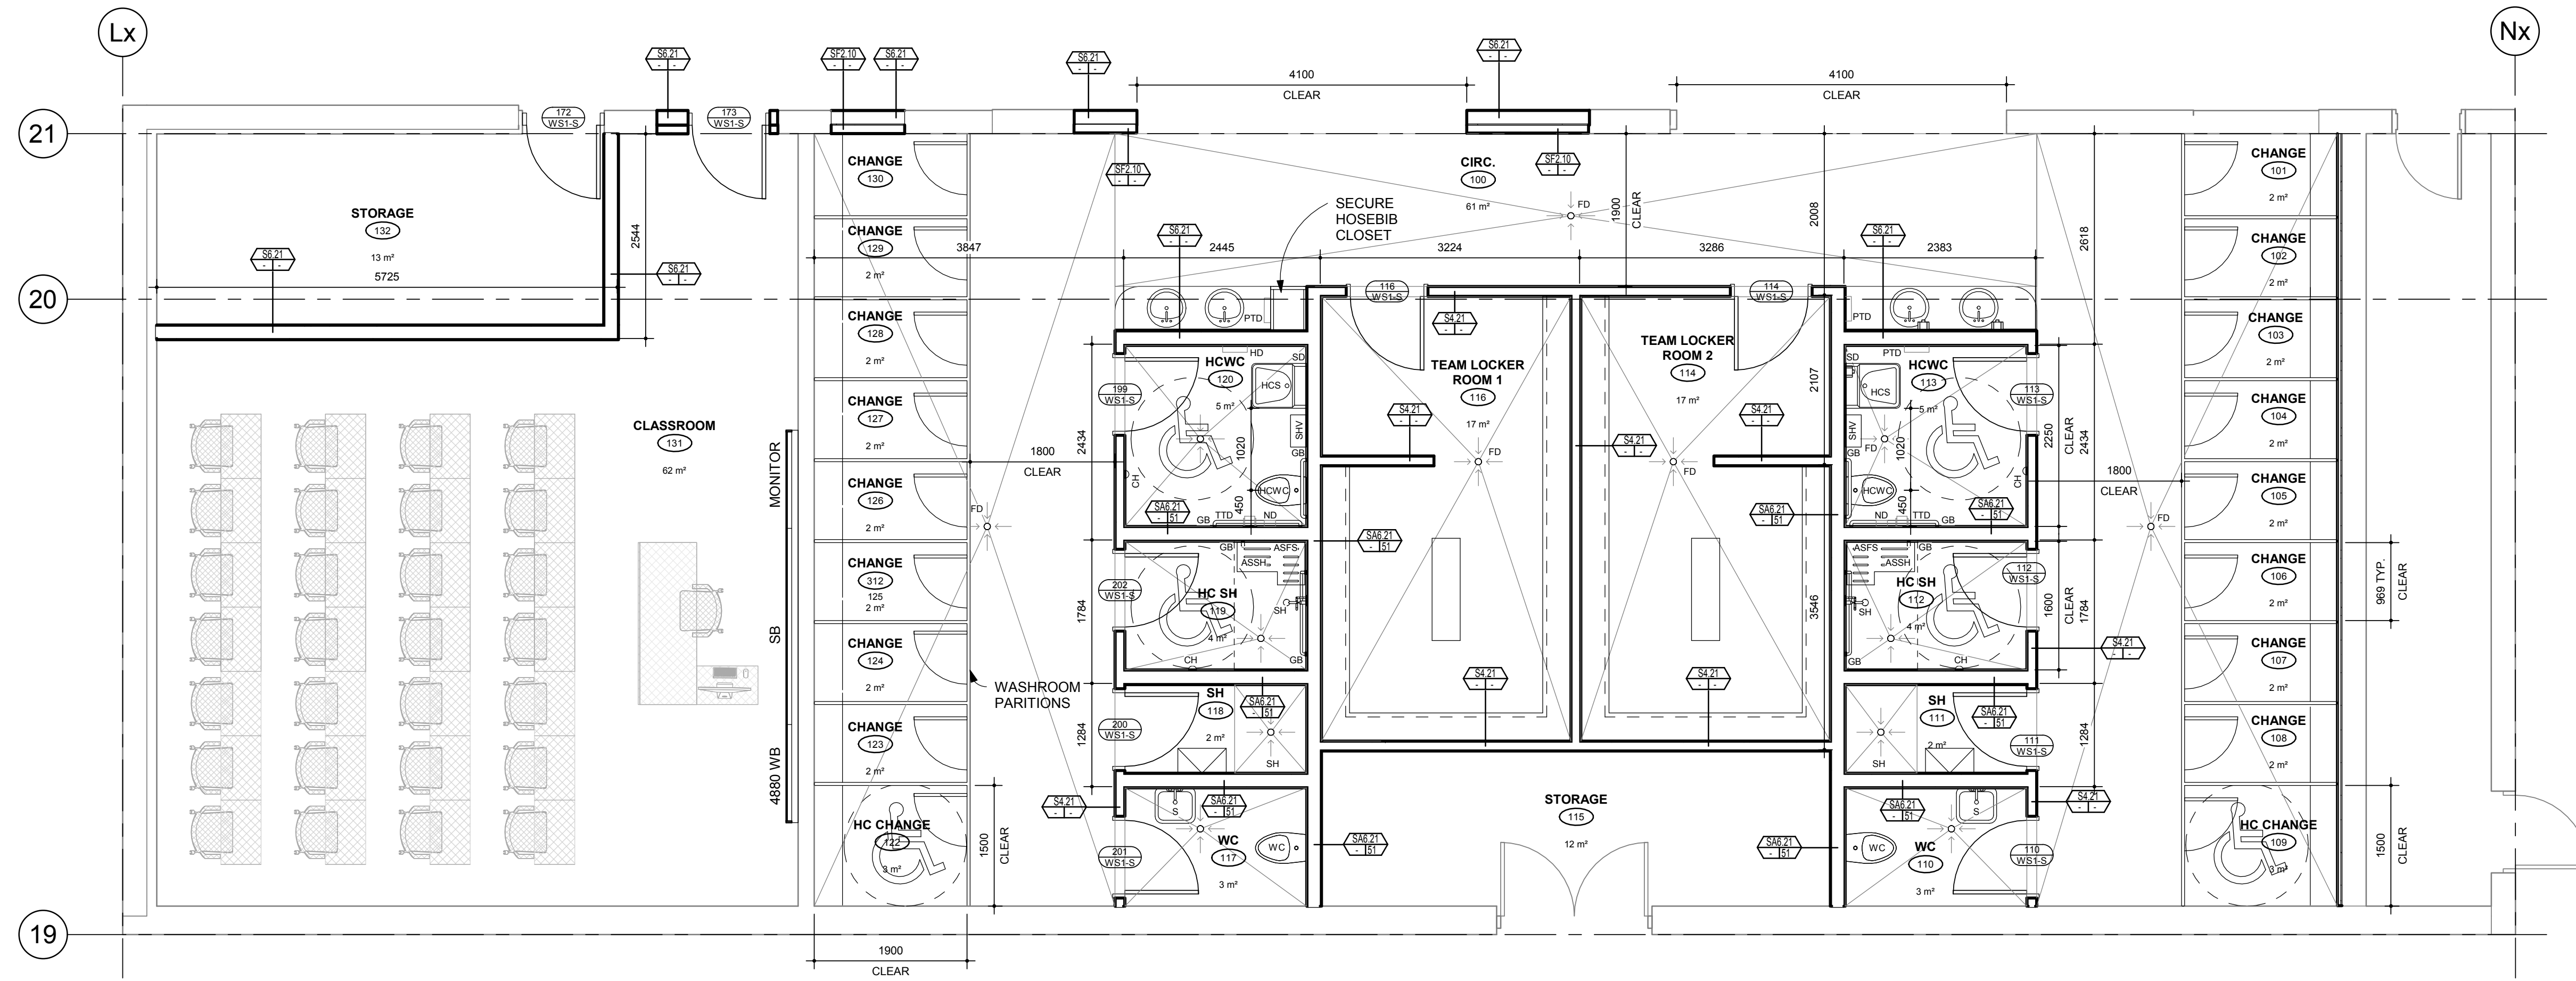1 A201 - MAIN FLOOR

1:50

WALL LEGEND	
FIRE SEPARATIONS	
PATTERN	FRR
	0 HR
	3/4 HR
	1 HR
	2 HRS



- INTERIOR WALL SCHEDULE NOTES**
- RATINGS REFERENCE BC BUILDING CODE 2018, EXCEPT WHERE OTHERWISE STATED.
 - ASSEMBLIES DESCRIBE BASIC REQUIREMENTS TO MEET RATING REQUIREMENTS. ADDITIONAL FINISHES MAY BE REQUIRED AS NOTED IN THE SPECIFICATIONS AND/OR ON THE DRAWINGS.
 - THIS SCHEDULE DOES NOT SUPERCEDE OTHER CONTRACT DOCUMENTATION AND IS TO BE READ IN CONJUNCTION WITH ALL OTHER DOCUMENTATION. FOR OTHER CONSTRUCTION SPECIFIC OR TECHNICAL REQUIREMENTS REFER TO THE SPECIFICATIONS AND DRAWINGS.
 - REFER TO CODE COMPLIANCE DRAWINGS FOR LOCATIONS OF REQUIRED FIRE RATED SEPARATIONS.
 - REFER TO ROOM FINISH SCHEDULE FOR LOCATIONS FOR IMPACT RESISTANT TYPE 'X' GWB AND IMPACT AND MOISTURE RESISTANT TYPE 'X' GWB, CEMENTITIOUS BACKER BOARD AND 0.15mm POLYETHYLENE TO 2200mm AFF. IMPACT AND MOISTURE RESISTANT TYPE 'X' GWB ABOVE REQUIRED IN ROOMS: 3.06, 3.07, 7.15
 - REFER TO FLOOR PLANS FOR REQUIRED RATING AND LOCATIONS
 - PROVIDE SOLID BLOCKING IN WALLS FOR ALL WALL MOUNTED EQUIPMENT, FIXTURES AND MILLWORK.

INTERIOR STEEL STUD WALL ASSEMBLIES SCHEDULE				
TYPE		(Note 6) STC	(Note 4) FRR	(Note 1) ULC
S3.20				
S6.21				
SA6.21		51		
S4.21				

STEEL FURRING ASSEMBLIES SCHEDULE				
TYPE		(Note 6) STC	(Note 4) FRR	(Note 1) ULC
SF2.10				

FLOOR PLAN LEGEND	
	GLAZING TYPE REFER TO DRAWING A9.3.XX
	DOOR REFERENCE DOOR NUMBER S = SINGLE DOOR; D = DOUBLE DOOR DOOR TYPE EQUIPMENT / FURNITURE REFERENCE REFER TO SPECIFICATION REFER TO ROOM DATA SHEETS REFER TO A0.3.XX
	INTERIOR ELEVATIONS DRAWING NUMBER PAGE NUMBER
	WALL TYPE WALL TYPE STC FRR (hrs.)
	AFF. ABOVE FINISHED FLOOR
	ASFS ACCESSIBLE SHOWER FOLDING SEAT
	ASSH ACCESSIBLE SHOWER SOAP HOLDER - RECESSED
	BH BENCH
	CG CORNER GUARD AS SPECIFIED
	CR CARD READERS
	CS CHANGING STALL
	DF DRINKING FOUNTAIN
	FD FLOOR DRAIN - REFER TO MECHANICAL
	FEC FIRE EXTINGUISHER CABINET
	FR FREEZER
	GB GRAB BAR
	HCWC ACCESSIBLE WATER CLOSET
	HCS ACCESSIBLE SINK
	L LAVATORY
	ND NAPKIN DISPOSAL BIN
	MS METAL SHELVING
	MB MOBILE BIN
	MR MIRROR
	O/F OUTSIDE FACE
	PB PUSH BUTTON HC ACCESS
	PRB PAPER RECYCLE BINS (OSO)
	PNL ELECTRICAL PANEL
	PTD PAPER TOWEL DISPENSER
	RFD FLOOR DRAINS TO BE ROUGHED IN ONLY
	RWL RAIN WATER LEADER - REFER TO MECHANICAL
	R/O ROUGH OPENING
	S SINK
	SD SOAP DISPENSER
	SH SHOWER
	SS JANITOR'S SINK
	TTD TOILET PAPER DISPENSER
	U URINAL
	U/C UNDER COUNTER
	US URINAL SCREEN
	WC WATER CLOSET
	DT-HL DOUBLE TIER HALF HEIGHT LOCKERS
	ST-HL SINGLE TIER HALF HEIGHT LOCKERS WITH MILLWORK COUNTER OVER
	ST-FL SINGLE TIER FULL HEIGHT LOCKERS

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PROJECT TITLE:
PORT ALBERNI SECONDARY - CHANGE ROOM RENOVATION

4000 Roger St, Port Alberni, BC V9Y 0B1
 CLIENT:

SCHOOL DISTRICT NO. 70 (ALBERNI)


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MAIN FLOOR PLAN

PROJECT NUMBER:
20354

DRAWN: VOL SCALE: As indicated

DATE: 05-12-20

DRAWING NUMBER:

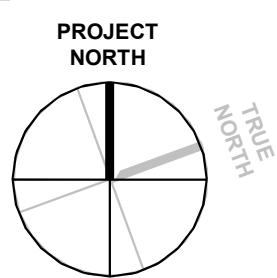


DESIGN DEVELOPMENT

A2.1.1

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REVISION - RECORD		
No.	DATE	DESCRIPTION

1 A202 - MAIN FLOOR - FINISH PLAN
 1:50

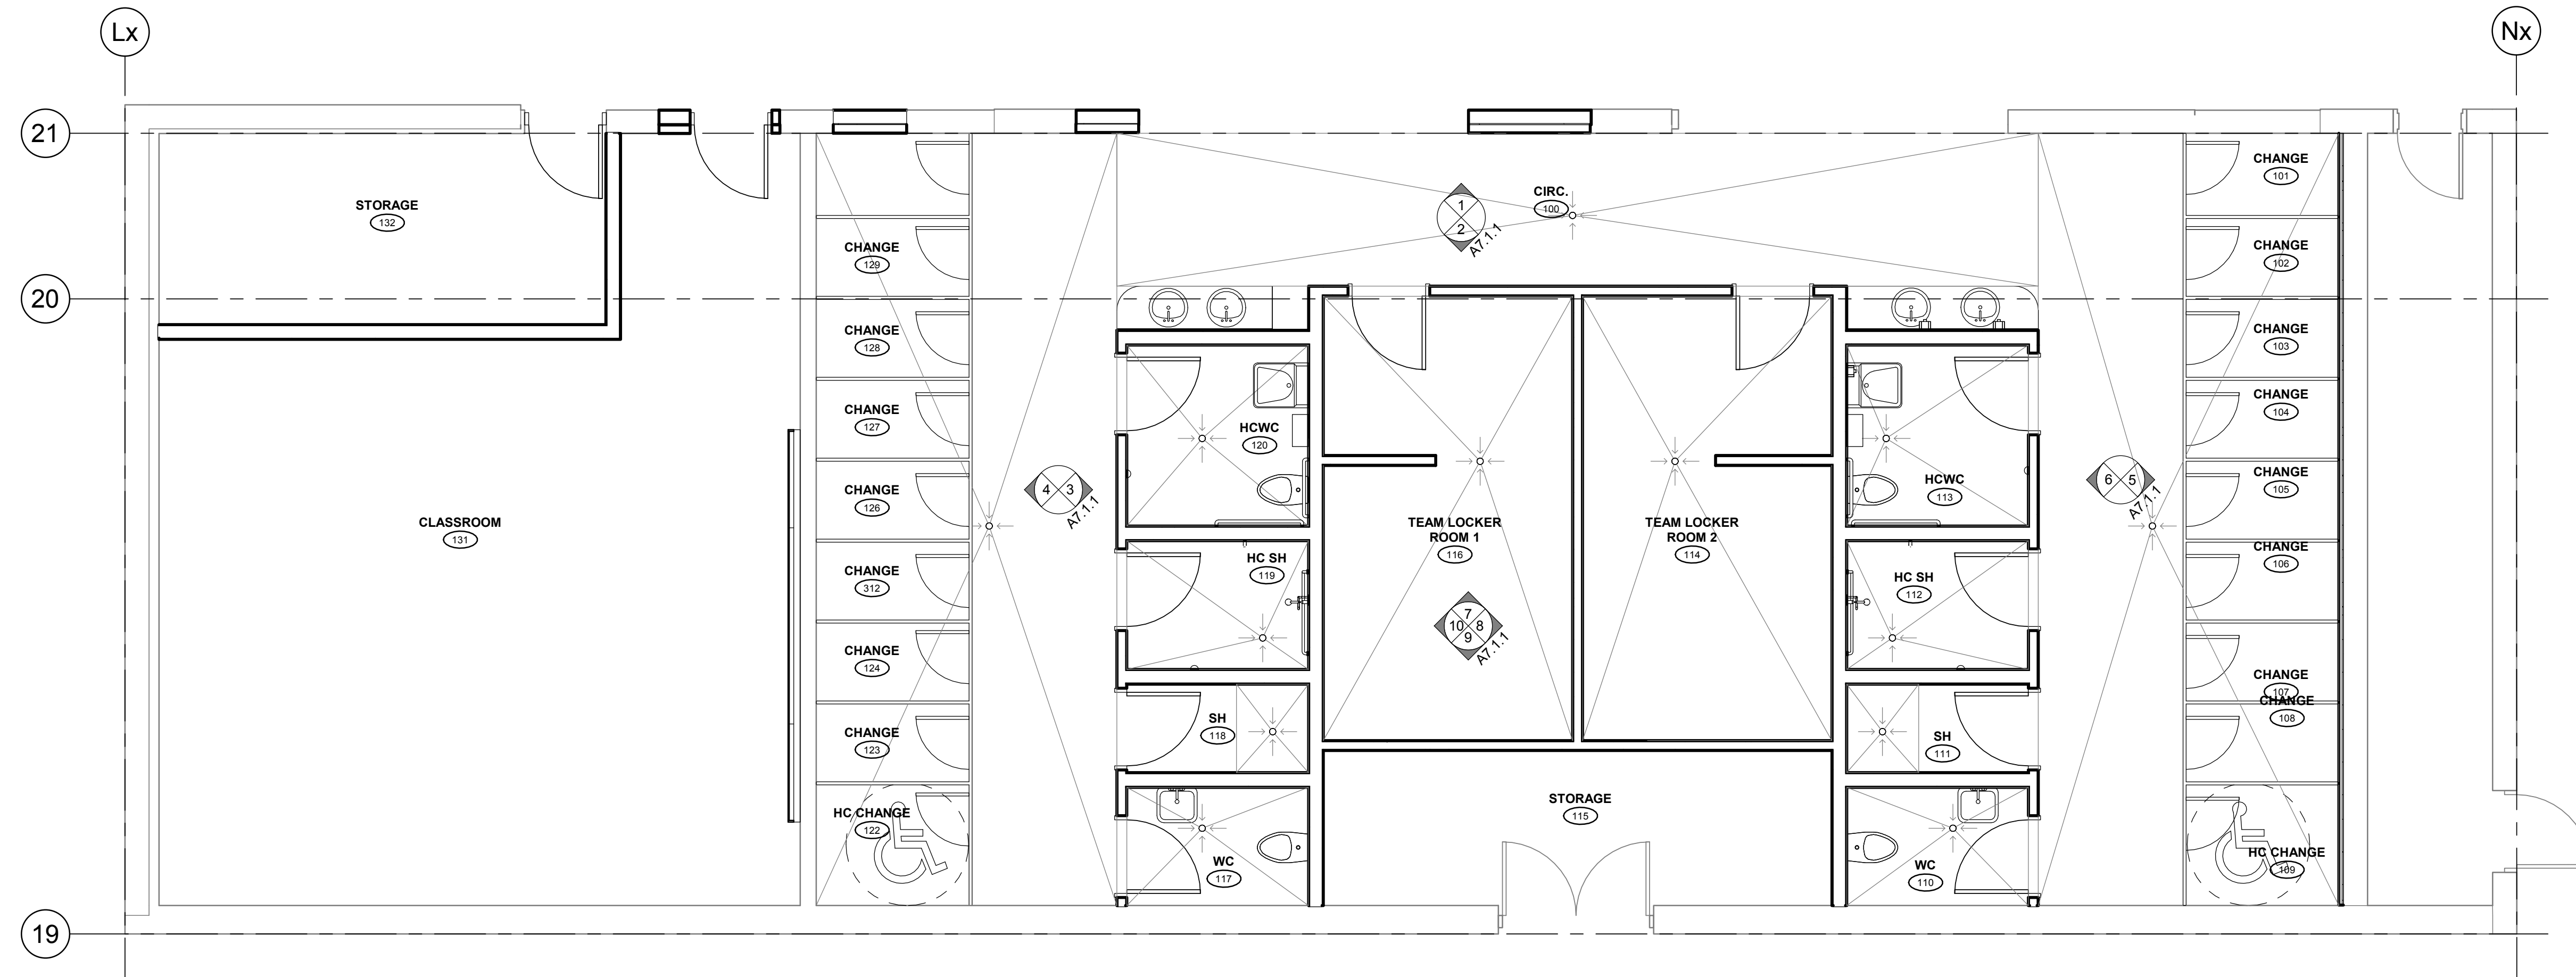5/19/2020 7:30:50 PM

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PROJECT TITLE:
**PORT ALBERNI
 SECONDARY -
 CHANGE ROOM
 RENOVATION**

4000 Roger St, Port Alberni, BC V9Y 0B1
 CLIENT:
**SCHOOL DISTRICT
 NO. 70 (ALBERNI)**

DRAWING TITLE:
**FLOOR FINISH &
 INTERIOR PLAN**


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20354

DRAWN: Author SCALE: 1:50

DATE: 05/13/20

DRAWING NUMBER:

A2.2.1

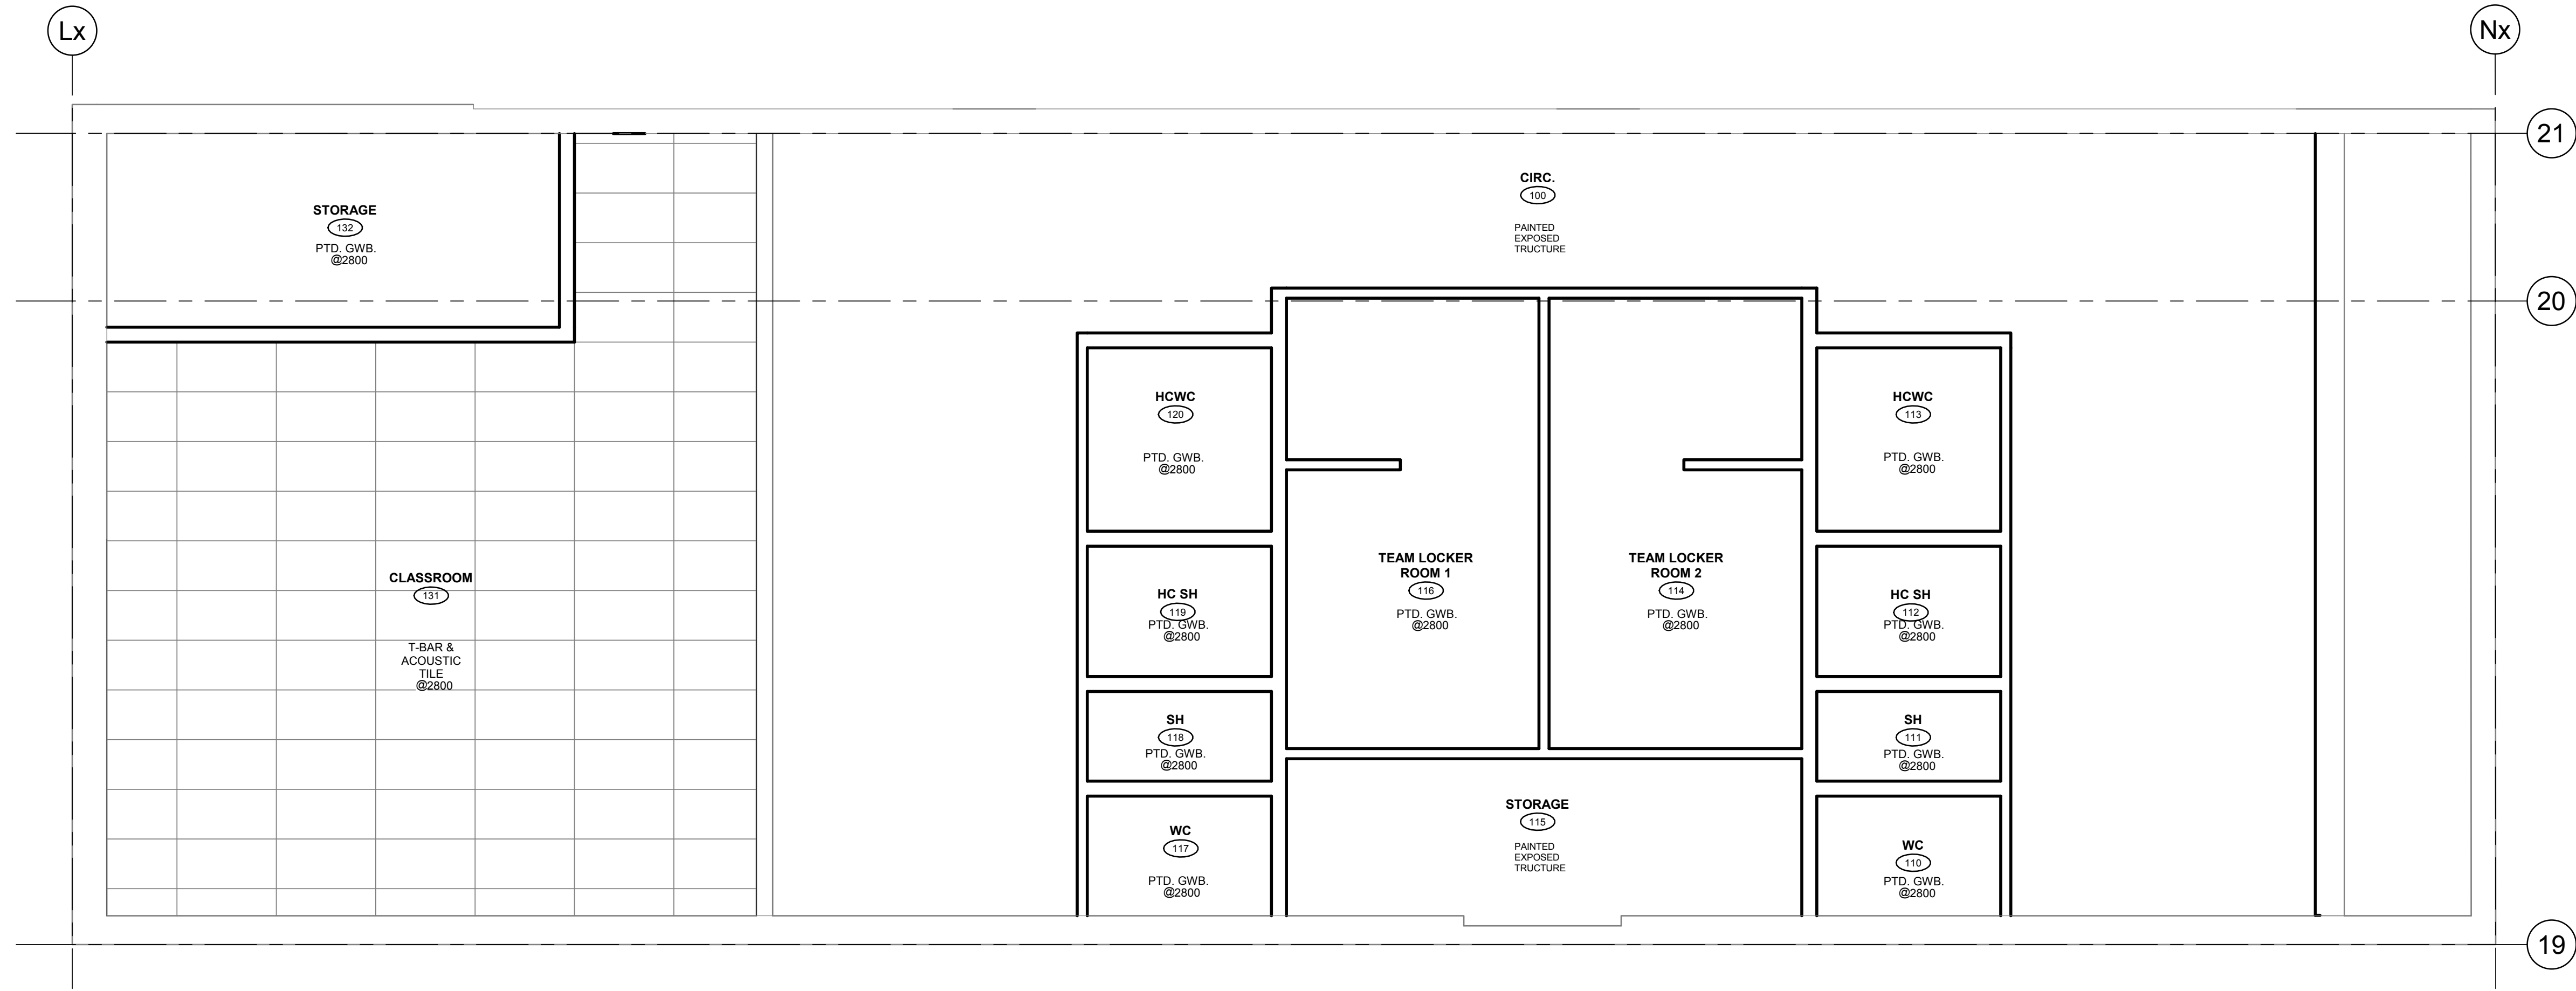


REVISION - RECORD		
No.	DATE	DESCRIPTION

1 MAIN FLOOR REFLECTED CEILING PLAN
 1:50

- REFLECTED CEILING PLAN NOTES**
1. CEILING HEIGHTS ARE FROM ASSOCIATED FLOOR LEVEL, TOP OF SLAB OR SHEATHING FOR EXTENT & HEIGHT OF BULKHEADS OVER DOORWAYS, WINDOWS & SCREENS. COORDINATE WITH DOORS, WINDOWS & SCREENS SCHEDULES
 2. ALL EXPOSED MECHANICAL DUCTS, PLUMBING/ SPRINKLER LINES, ELECTRICAL CONDUITS & STRUCTURE TO BE PAINTED U.N.O.
 3. REFLECTED CEILING PLANS ARE TO BE READ IN CONJUNCTION WITH SPECIFICATIONS, ROOM FINISHES SCHEDULE, ROOM DATA SHEETS AND INTERIOR DETAILS
 4. REFER ALSO TO MECHANICAL, ELECTRICAL, LIGHTING & FIRE PROTECTION DRAWINGS
 5. PROVIDE ACCESS PANELS WITH F.R.R. AS REQUIRED TO MATCH ASSEMBLIES BEING PENETRATED PROVIDE FIRE PROTECTION TO STRUCTURE AS REQUIRED PER CODE COMPLIANCE DRAWINGS

REFLECTED CEILING PLAN LEGEND

	GYPSUM WALL BOARD CEILING (PAINTED)
	16mm THICK 610mm x 1220mm ACOUSTIC CEILING TILE IN SUSPENDED T-BAR GRID, UNLESS NOTED OTHERWISE
	LIGHT FIXTURE- SEE ELEC. DWGS.
	CEILING OR PENDANT MOUNTED LUMINAIRE - SEE ELEC. DWGS.
	MECHANICAL SUPPLY DIFFUSER -SEE MECH. DWGS.
	MECHANICAL SUPPLY DUCT RISER/ SECTION - SEE MECH. DWGS.
	MECHANICAL RETURN & EXHAUST GRILLE - SEE MECH. DWGS.
	MECHANICAL OUTDOOR AIR DUCT RISER/ SECTION - SEE MECH. DWGS.

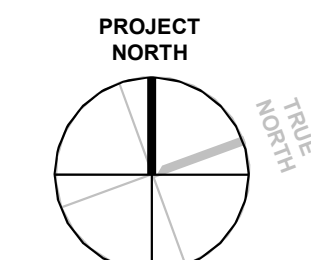

DESIGN DEVELOPMENT

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PROJECT TITLE:
**PORT ALBERNI
 SECONDARY -
 CHANGE ROOM
 RENOVATION**

4000 Roger St, Port Alberni, BC V9Y 0B1
 CLIENT:

**SCHOOL DISTRICT
 NO. 70 (ALBERNI)**

DRAWING TITLE:
**REFLECTED CEILING
 PLANS**

PROJECT NUMBER:
20354

DRAWN: VOL SCALE: As indicated

DATE: 05-12-20

DRAWING NUMBER:

A3.1.1

